

Staff Report for Decision

File Number: DVP00406

DATE OF MEETING December 21, 2020

AUTHORED BY SADIE ROBINSON, PLANNING ASSISTANT, CURRENT PLANNING

SUBJECT DEVELOPMENT VARIANCE PERMIT APPLICATION NO. DVP406 –

164 HOLLAND ROAD

OVERVIEW

Purpose of Report

To present for Council's consideration, a development variance permit application to increase the maximum allowable gross floor area and maximum allowable building height for a proposed accessory building at 164 Holland Road.

Recommendation

That Council issue Development Variance Permit No. DVP406 at 164 Holland Road with the following variances:

- increase the maximum allowable gross floor area for all accessory buildings from 90m² to 243m²; and
- increase the maximum allowable height for a proposed accessory building from 7m to 7.85m.

BACKGROUND

A development variance permit application, DVP406, was received from Craig Jones to vary the provisions of the "City of Nanaimo Zoning Bylaw 2011 No. 4500" (the "Zoning Bylaw") to increase the maximum allowable gross floor area and the maximum allowable building height for a proposed accessory building to be located within the subject property at 164 Holland Road.

Subject Property and Site Context:

Zoning	AR2 – Urban Reserve
Location	The subject property is located on Holland Road between
	Jingle Pot Road and East Wellington Road.
Total Area	8,549m ²
Official Community Plan	Map 1 – Future Land Use – Urban Reserve

The subject property is a large residential lot with an existing house that is located in an area characterized by rural single family homes, some with agricultural uses. The owners have an active building permit for an addition to the existing dwelling.

Statutory notification has taken place prior to Council's consideration of the proposed variances.



DISCUSSION

Proposed Development

The proposed development is a 243m² accessory building containing a garage, shop and storage, located on a lot with an existing house. The accessory building is proposed to be sited within the northwest corner of the lot, adjacent to the panhandle of a neighbouring residential lot. The accessory building is intended to be used for storage, including large equipment, tools, and vehicles for yard maintenance and recreation.

In order to maintain the character of the property, the property owners have opted to finish the proposed accessory building with the same 6:12 roof pitch and materials used on the principle dwelling, such as Hardie planks and cedar shingles, on the gables. There are a number of mature trees on the property frontage that should partially screen the accessory building, given its proposed siting.

Proposed Variances

Accessory Building Floor Area

The maximum allowable gross floor area (GFA) for an accessory building is 90m². The proposed GFA is 243m²; a proposed variance of 153m².

The proposed accessory building is located in the northwest corner of the lot. The accessory building is proposed to be set back 10.2m from the north property line (the panhandle), which exceeds the minimum required setback of 1.5m. The nearest house on a neighbouring property is approximately 52m to the south of the proposed structure. The area for the proposed oversized accessory building is already mostly cleared, and minimal tree removal will be required to accommodate the proposed accessory building.

Despite the increase in GFA, the building would still be ancillary in size to the existing principal dwelling (317.8m²). Additionally, the building complies with zoning requirements for lot coverage and setbacks. The Zoning Bylaw allows 13% of the lot size (1,111m²) or 90m² of Gross Floor Area for all accessory structures, whichever is lesser. In this case, the proposed 243m² building represents 2.8% of the total lot area. No other accessory structures are proposed or existing on the lot. The applicant is clustering the GFA within a single building rather than having multiple outbuildings on the site, allowing for a more functional yard area.

Accessory Building Height

Accessory buildings located within the permitted setbacks of a principal building are permitted a maximum height of 7m, regardless of the roof pitch. The proposed accessory building height is 7.85m; a proposed variance of 0.85m.

A variance to the maximum allowable accessory building height is proposed to achieve a building height that will accommodate the storage of larger items, such as the owner's recreational vehicle, and will accommodate storage in an upper loft.

The accessory building will be well separated from neighbouring residences and no negative impacts are anticipated.



Staff support the proposed variances.

SUMMARY POINTS

- Development Variance Permit No. DVP406 proposes a variance to increase the maximum allowable gross floor area, and the maximum allowable height for an accessory building on an AR2-zoned lot.
- The new accessory building meets all lot coverage and setback requirements.
- No negative impacts on neighbouring properties are anticipated.

<u>ATTACHMENTS</u>

ATTACHMENT A: Permit Terms and Conditions

ATTACHMENT B: Context Map ATTACHMENT C: Location Plan ATTACHMENT D: Survey Plan

ATTACHMENT E: Accessory Building Elevations

ATTACHMENT F: Aerial Photo

Submitted by: Concurrence by:

Lainya Rowett Jeremy Holm
Manager, Current Planning Director, Development Approvals

Dale Lindsay
General Manager, Development Services

ATTACHMENT A PERMIT TERMS AND CONDITIONS

TERMS OF PERMIT


The "City of Nanaimo Zoning Bylaw 2011 No. 4500" is varied as follows:

- 1. Section 6.6.6 Maximum Gross Floor Area to increase the maximum allowable gross floor area for all accessory buildings on the subject property from 90m² to 243m².
- 2. Section 6.6.5.1. b) Maximum Height of an Accessory Building to increase the maximum allowable height of the proposed accessory building from 7m to 7.85m.

CONDITIONS OF PERMIT

- 1. The subject property shall be developed in accordance with the Survey Plan prepared by Dirkson Design Services, received 2020-JUL-30, as shown on Attachment D.
- 2. The proposed accessory building shall be developed in accordance with the Accessory Building Elevations prepared by Dirkson Design Services, dated 2020-MAR-21, as shown on Attachment E.

ATTACHMENT B CONTEXT MAP

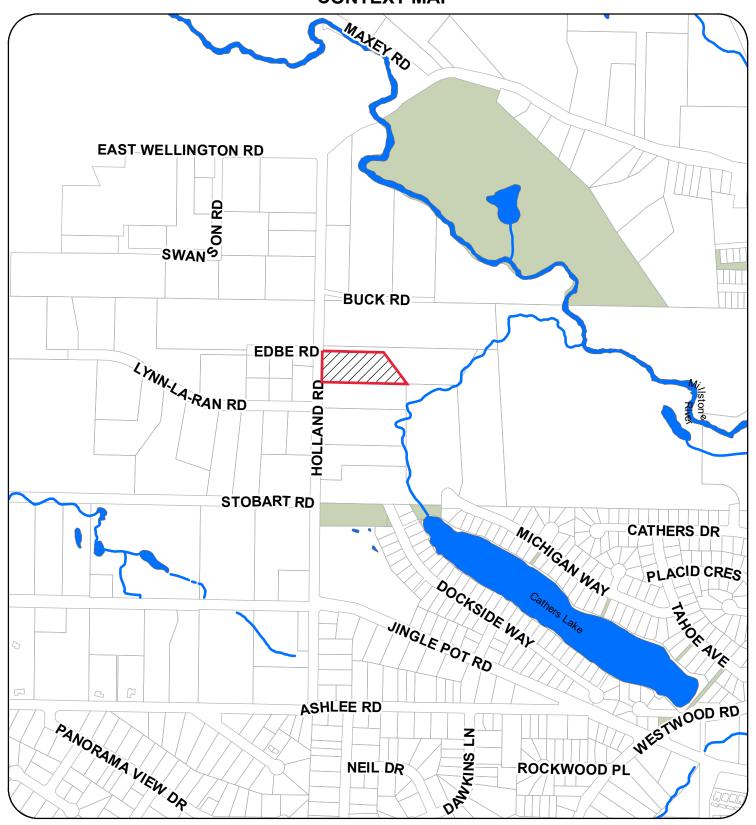

DEVELOPMENT VARIANCE PERMIT APPLICATION NO. DVP00406





ATTACHMENT C LOCATION PLAN





DEVELOPMENT VARIANCE PERMIT NO. DVP00406

Subject Property

CIVIC: 164 HOLLAND ROAD

LEGAL: LOT A, SECTION 13, RANGE 7, MOUNTAIN DISTRICT, PLAN VIP78968

ATTACHMENT D PLAN NO. 54800388 **SURVEY PLAN** PLAN OF SUBDIVISION OF LOT 2, PL/... SURV DEPOSITED IN THE LAND TITLE OFFICE AT VICTORIA.
B. C. THIS DAY OF MANY 20 05. SECTION 13, RANGE 7, MOUNTAIN DISTRICT DEPUTY REGISTRAR: SCALE 1: 1000 B. C. G. S. 92G . 011 _, 20 **05** APPROVING OFFICER, All distances are in matres, LEGEND: BEARINGS ARE ASTRONOMIC AND ARE DERIVED FROM PLAN 41146 DENOTES STANDARD IRON POST FOUND DENOTES STANDARD IRON POST PLACED -12, 000 B9° 47' 07" 119, 177 PLAN 41146 LOT 1 **Proposed Accessory** Building (see inset, right) 4 89" 47' 07" 305, 438 46 89* 47' 07" -EXISTING BUILDING 97 119, 177 359, 59. ARE FOLLAND PLAN 47' 23" ੱਚਤਾ 47' 23' 165, 972 LEIGH A. MILLAN LOT B PLAN VIP63137 PLAN 41146 LOT 5 BRITISH COLLABBIA I, LEIGH A. MILLAN, A BRITISH COLUMBIA LAND SURVEYOR, OF MANAIMO, IN BRITISH COLUMBIA, CERTIFY THAT I WAS PRESENT AT AND PERSONALLY LAND SURVEYOR CANADA LANDS SURVEYOR SUPERINTENDED THE SURVEY REPRESENTED BY THIS PLAN, AND THAT THE SURVEY AND PLAN ARE CORRECT. SUITE NUMBER 7 THE FIELD SURVEY WAS COMPLETED ON THE 20TH DAY OF MAY 2004. THE PLAN WAS COMPLETED AND CHECKED, AND THE CHECKLIST FILED UNDER #.15233.

ON THE 26TH DAY OF MAY 2004. 20 FRONT STREET NANAIMO, B.C. V9R-5H8 (250) -753-9181 FILE NO. 2551 LEIGH A. HILLAN, BCLS, CLS 370-30, 394-43 SHEINAL 2661SD1. Q THIS PLAN LIES WITHIN THE REGIONAL DISTRICT OF NANAIMO F. B. NO. COMP. FILE SHEET TITLE DIRKSON DESIGN SERVICES DEALGNED ARAL CONSULTANT SEAL SHEET NO.



PLANNERS

PO BOX \$14 STN A NANAMO, B.C. VSR 3N2

VBR 3N2 TEL, GBOJ 380-4114



AS NOTED

PRAIN RON

CHECKED

PAR MAR 21 2020


RENO 1. ADDITION
TO HOUSE
164 HOLLAND ROAD
NANAMO, BC




SITE PLAN ON SURVEY, Craig Jones -Reno Mar-20 CROSS-SECTIONS A-A & B-B




ATTACHMENT E ACCESSORY BUILDING ELEVATIONS

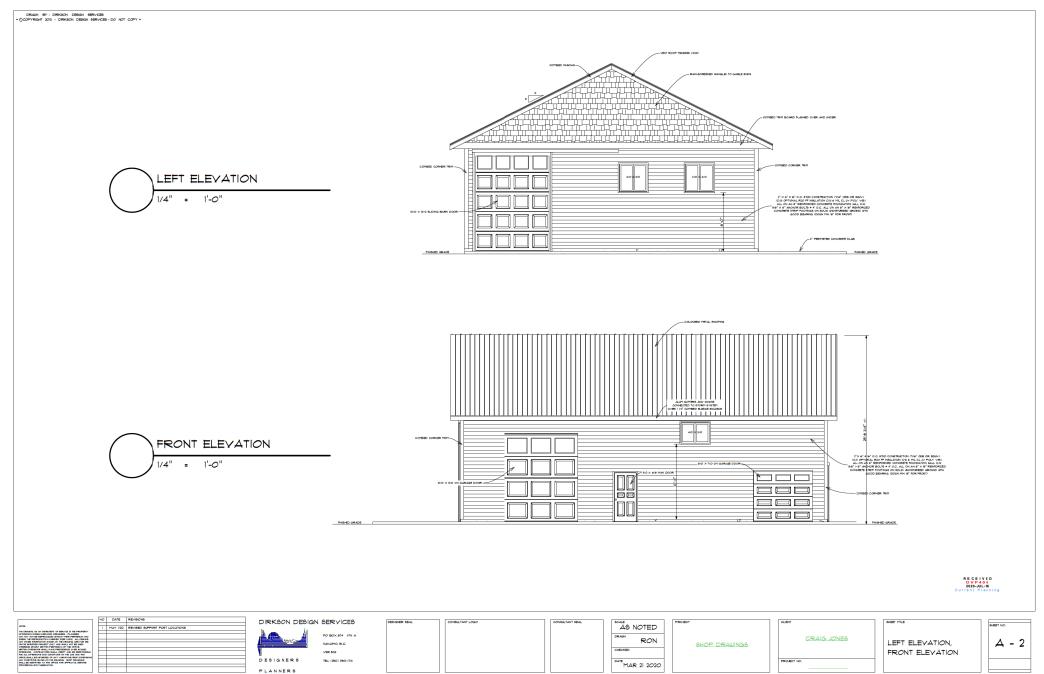

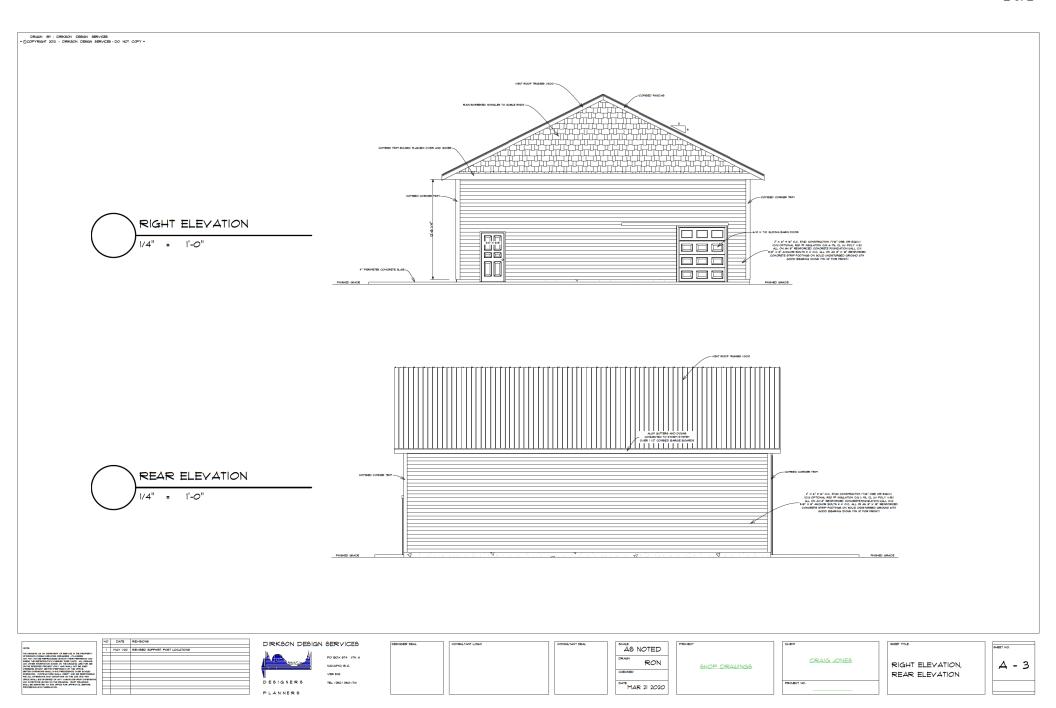

ATTACHMENT F AERIAL PHOTO

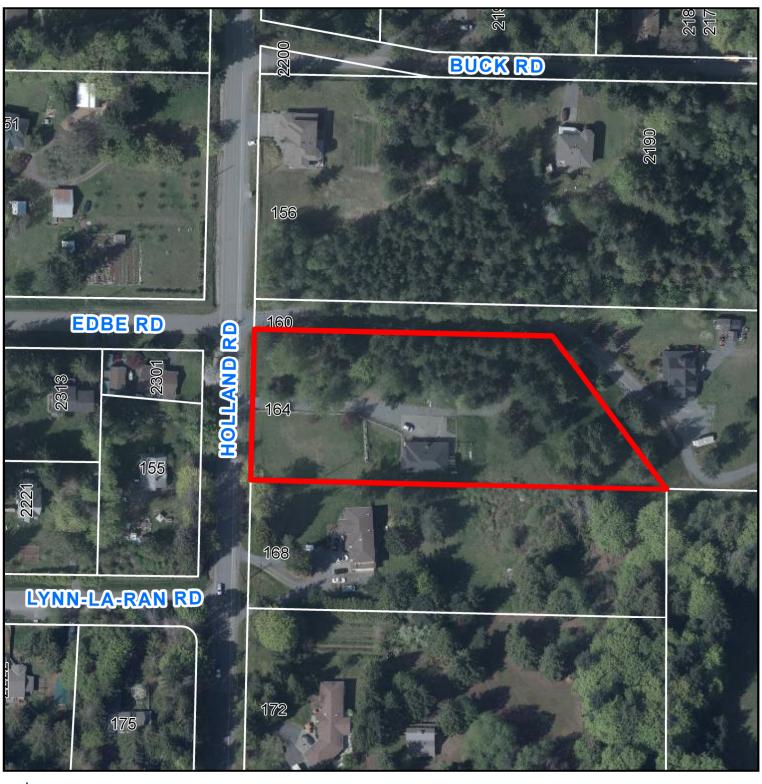



DEVELOPMENT VARIANCE PERMIT NO. DVP00406

